



# NOTES:

1. INDEX OF DRAWINGS FOR WORK UNDER THIS PROJECT:  
30-1 ARCHITECTURAL REV. 7-6-64  
M-1 MECHANICAL 7-1-64  
E-1 ELECTRICAL 7-1-64


2. FLOORS: THE EXISTING WOOD FLOOR IS TO BE Sanded smooth and clean and REFINISHED, NATURAL COLOR.
3. WALLS: CLOSE UP EXISTING WINDOWS ON THE ROOM SIDE TO THE HEIGHT SHOWN WITH METAL FURRING CHANNELS ANCHORED TO MASONRY, METAL LATH AND 5/8" THICK PLASTER.
4. CEILING: INSTALL NEW SUSPENDED CEILING AS DETAILED. PLASTER 5/8" THICK ON METAL LATH ON 3/4" METAL FURRING CHANNELS.  
  
REMOVABLE CEILING PANELS SHALL BE OVERSIZED FIBERGLASS PATTERNED TEXTURED CEILING TILE 48" X 48" X 1", ONE HOUR FIRE RATED. PROVIDE SAMPLE. SEE MECH. DWGS. FOR PANELS WITH DIFFUSERS.  
  
CEILING SUSPENSION SYSTEM SHALL BE SIMILAR TO FLANGEKLAMP CORP. BUFFALO, N.Y. BLINFORGE SYSTEM WHERE NECESSARY TO SUPPORT WORKMEN'S WEIGHT. PROVIDE 5 PCS. 3/4" THICK PLYWOOD, INSTALLED OVER CEILING PANELS IN VICINITY OF A.H. UNIT.
5. PAINTING: PAINT ALL WALLS, PLASTER CEILING, WOOD TRIM AND BASE.

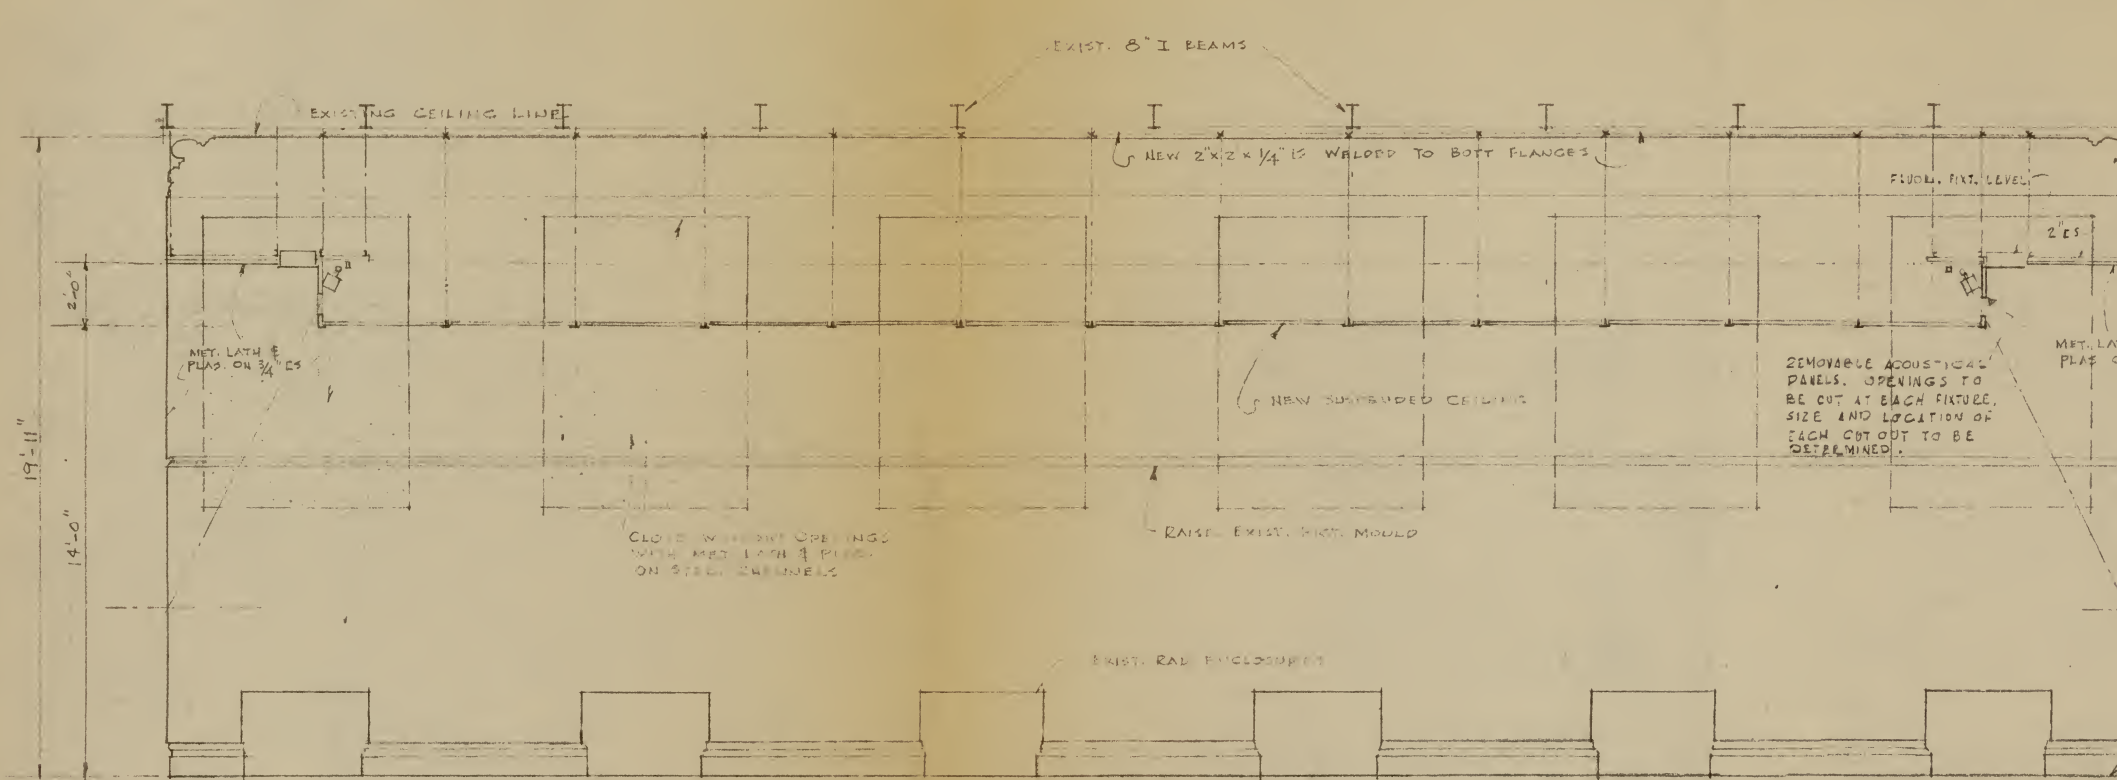


WEST ELEVATION - A-A  
SCALE: 1/4" = 1'-0"

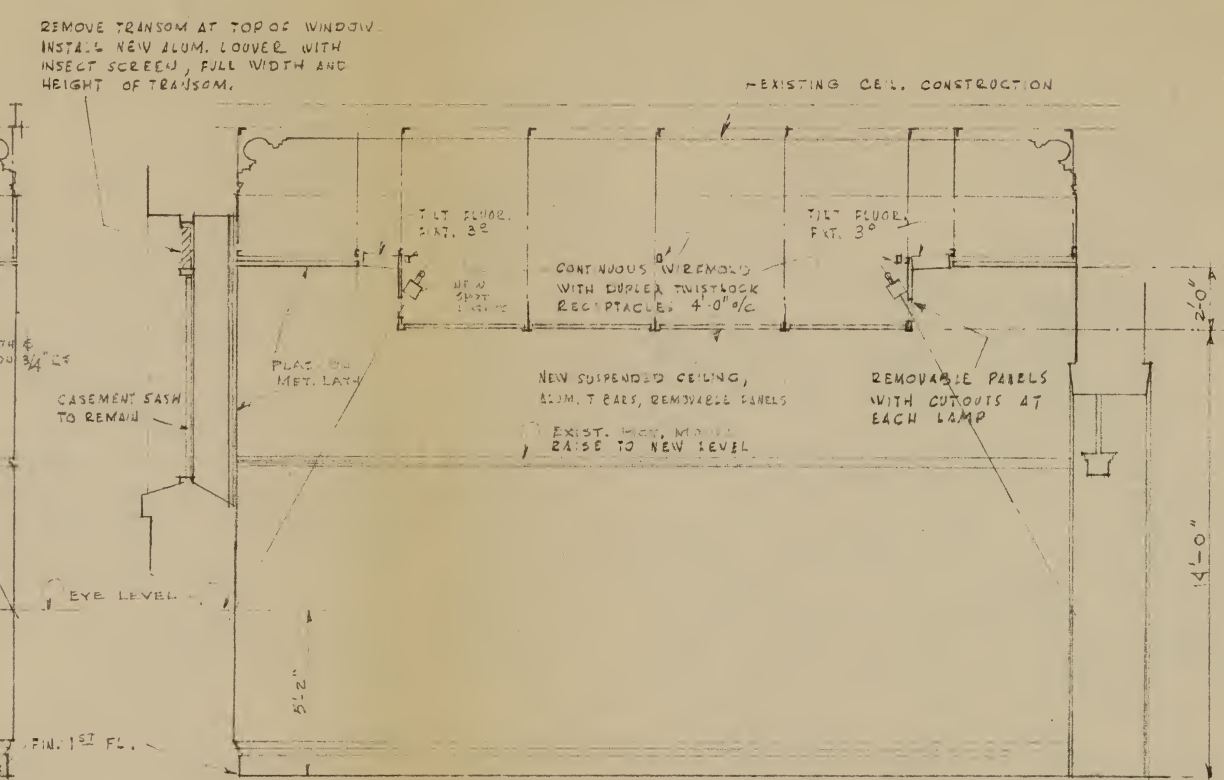

NORTH ELEVATION - B-B  
SCALE: 1/4" = 1'-0"  
SOUTH ELEVATION SIMILAR BUT REVERSED

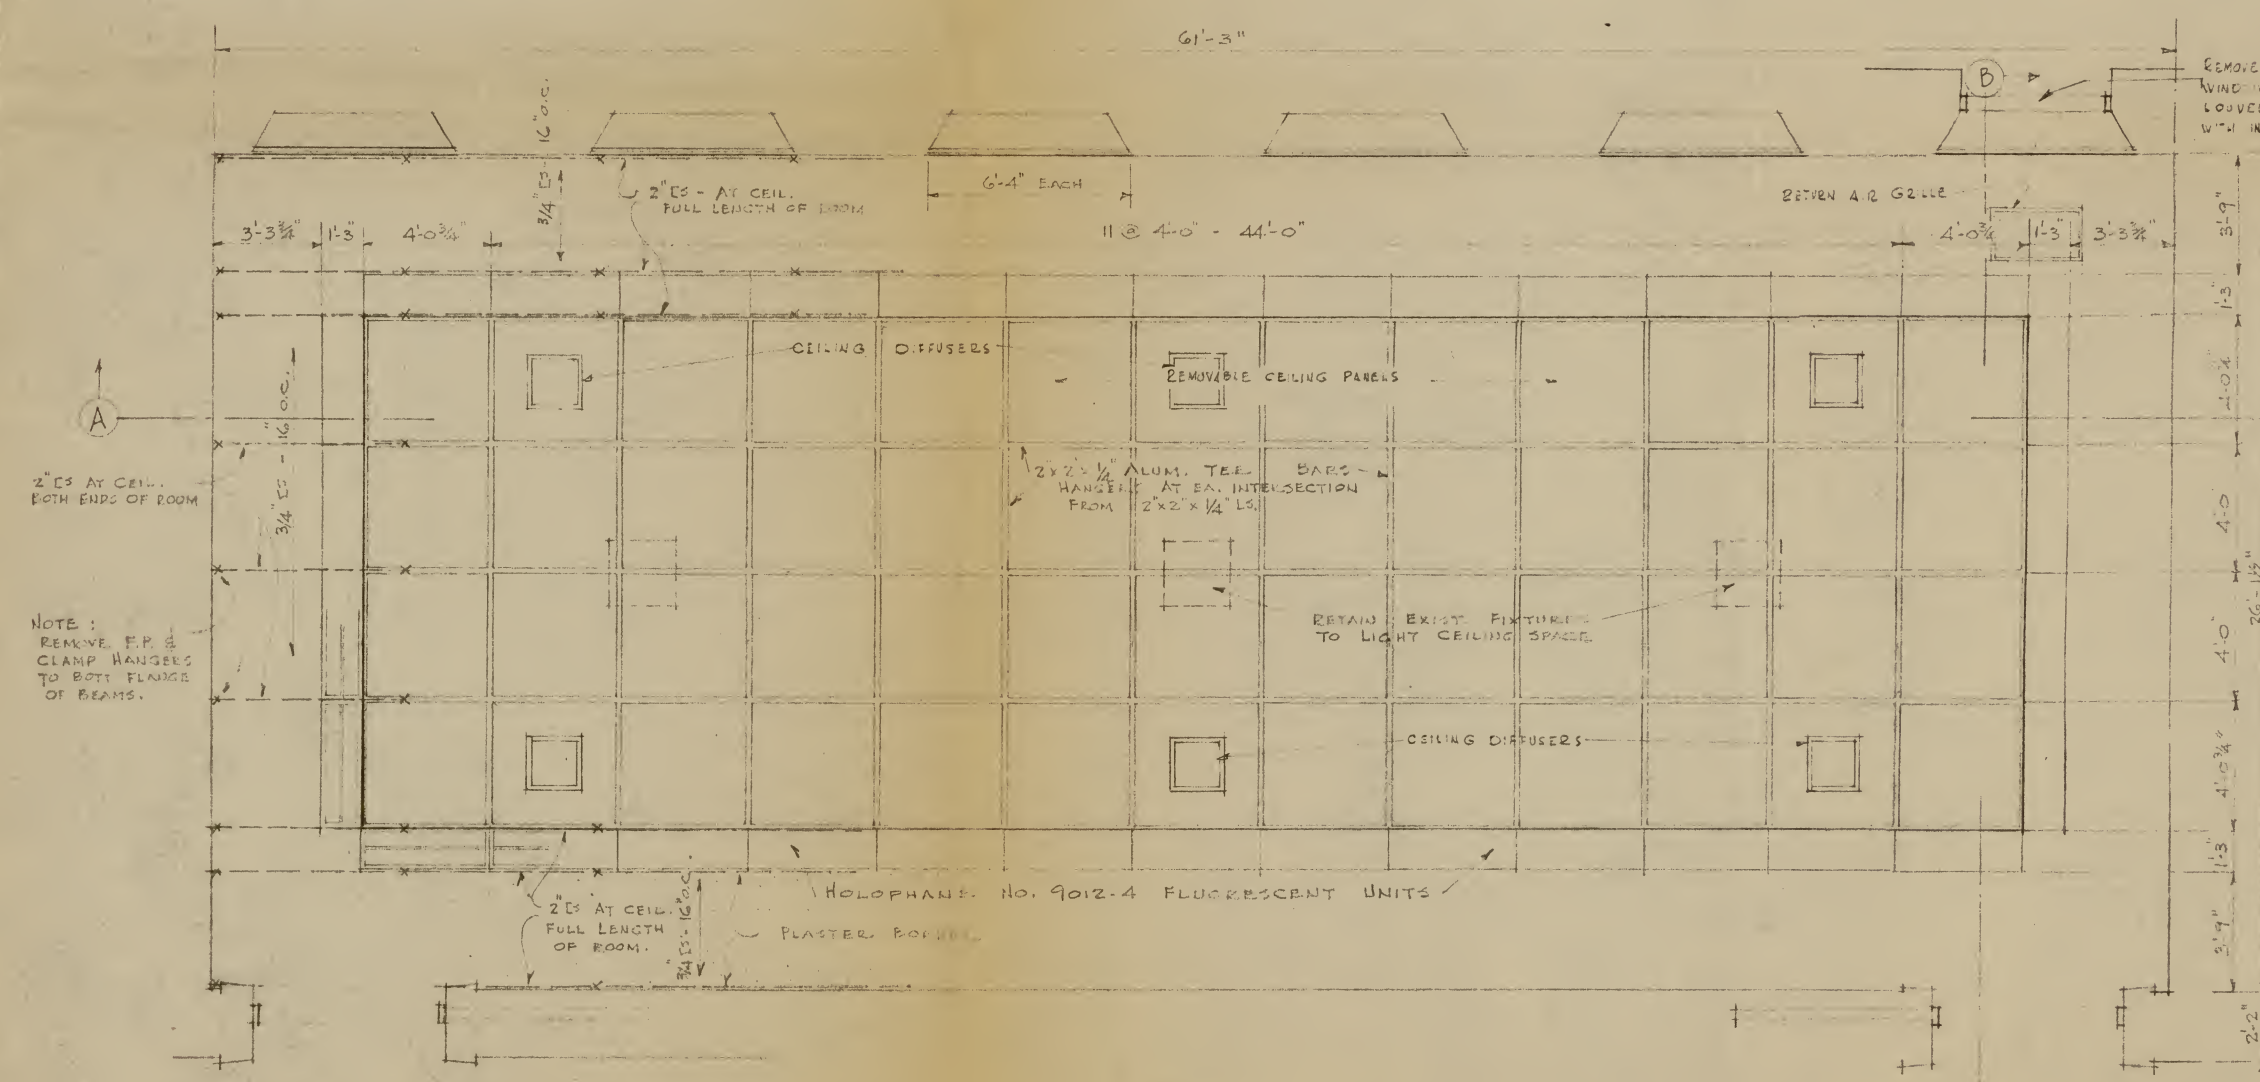

PLAN OF GALLERY 30 SHOWING REFLECTED CEILING  
SCALE: 1/4" = 1'-0"

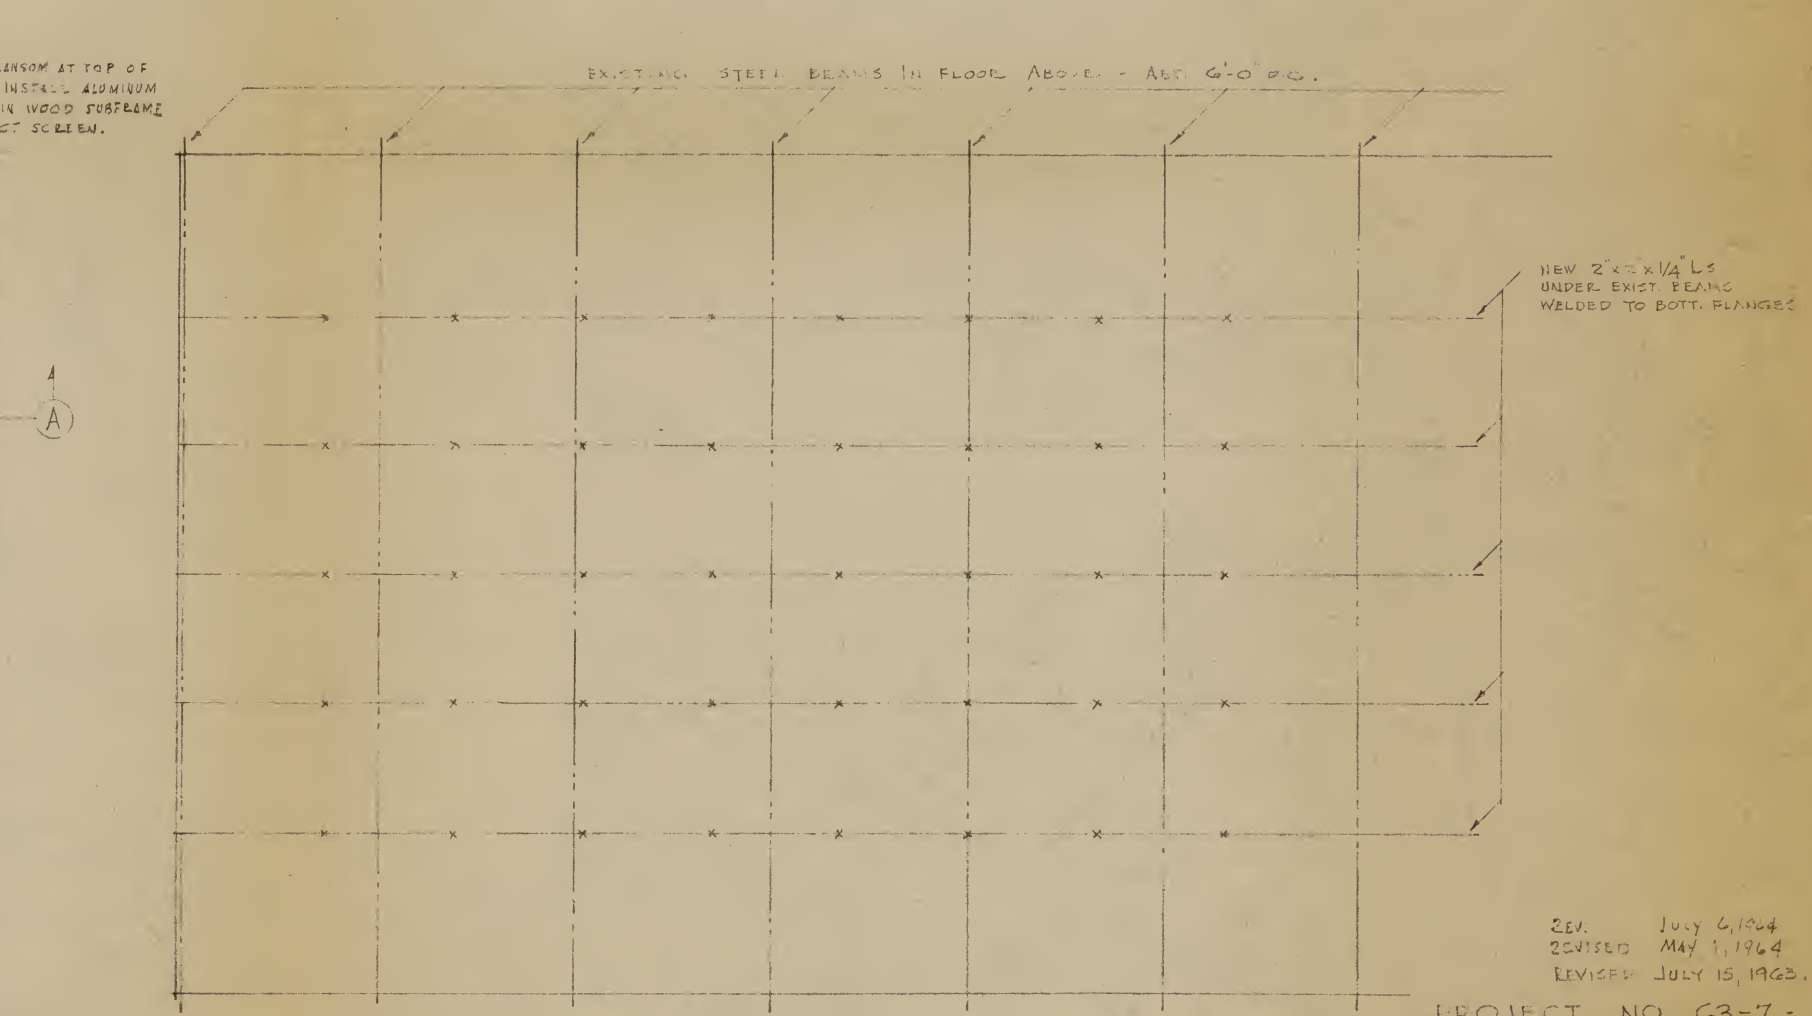


PART - FRAMING - PLAN  
SCALE: 1/4" = 1'-0"

NOTE:  
INSTALL WHERE DIRECTED ABOVE HUNG CEILING 6'-0" X 6'-0" PLATE GIRDS TO SUPPORT A 1200# AIR HANDLING UNIT - 1/4" STEEL GRATING 6" X 4" X 3/8" FRAME - 5/8" HANGERS 2012 CLAMPED TO BOTH FLANGES OF EXIST. BEAMS. SEE MECH. DWGS.


<p>THE CORCORAN GALLERY OF ART WASHINGTON, D.C.</p>		<p>DATE JUNE 6, 1963</p>
<p>FAULKNER, KINGSBURY &amp; STENHOUSE ARCHITECTS 1710 H STREET, N.W. WASHINGTON, D.C.</p>		<p>DRAWN BY EDS.</p>
<p>ALTERATIONS TO GALLERY 30</p>		<p>CHECKED BY JMS</p>
<p>SCALE: 1/4" = 1'-0"</p>		<p>30-1</p>

REV. July 6, 1964  
REVISED May 1, 1964  
REVISED July 15, 1965  
PROJECT NO. 63-7



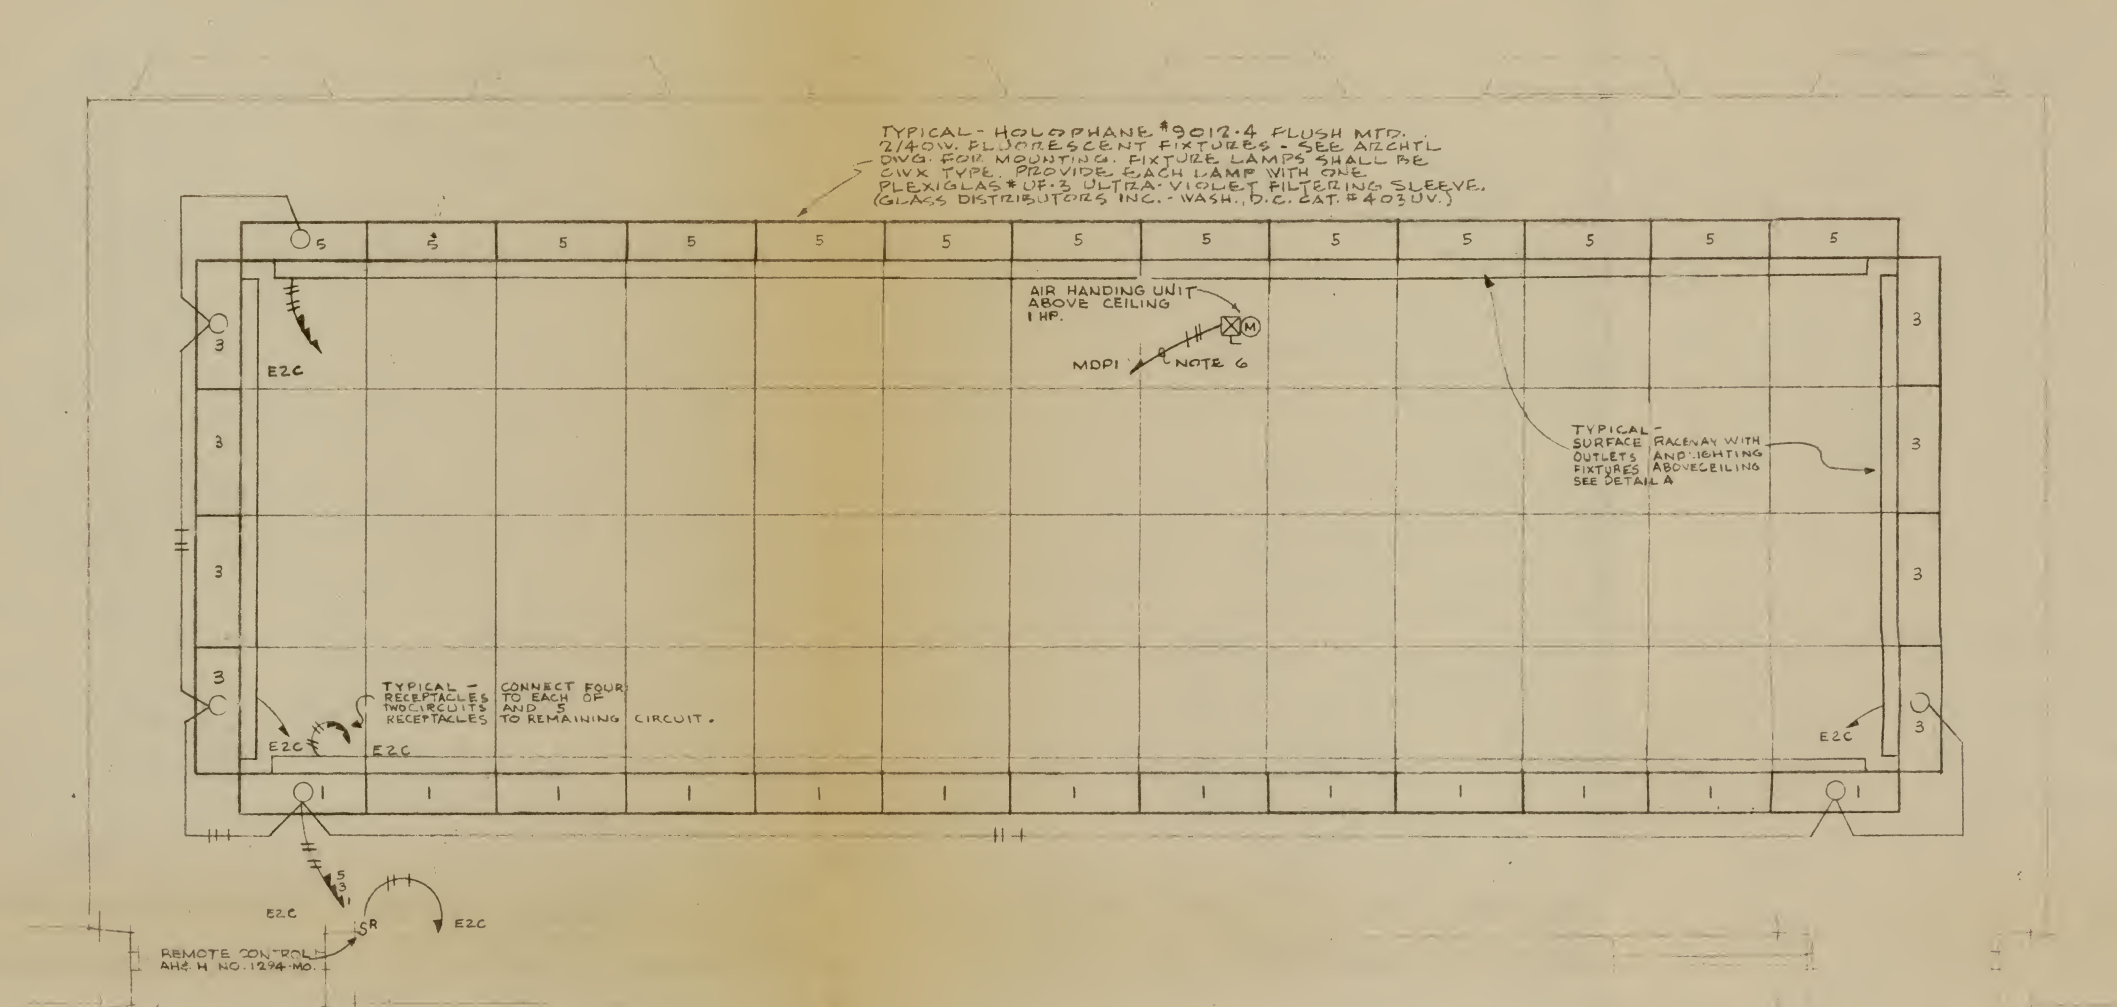

GALLERY 30 FLOOR PLAN  
SCALE 1/4" = 1'-0"

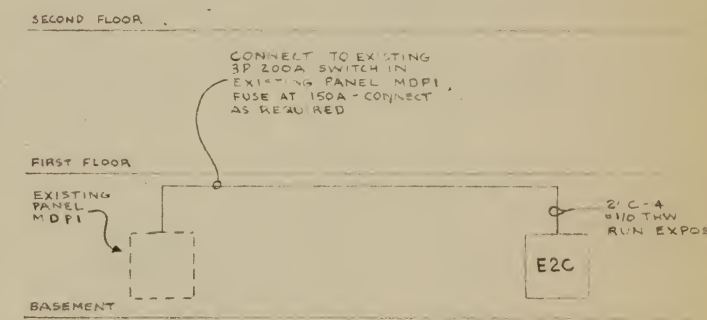


POWER RISER - ALTERNATE NO. 2  
NO SCALE

PANEL SCHEDULE

<b>E2C</b>	
SURFACE MOUNTED NQC TYPE	
QUICKLAG "C" C/B'S	
3Ø 4W S/N 120/208V	
3P 150A ASCO #9205C	
CONTACTOR IN MAINS	
BRANCHES:	LIGHTS IN GALLERY = 30
11-1P-20A	SPARES
11-1P-20A	SPARE ONLY
20-1P	
<b>NOTE:</b>	
PROVIDE PANEL E2C UNDER ALTERNATE NO. 2	

NOTES


1. ALL WIRE MINIMUM #12 UNLESS OTHERWISE NOTED.
2. SURFACE RACEWAY SHALL BE PLUGMOLD #200C AS MANUFACTURED BY WIREMOLD COMPANY AND SHALL HAVE AH&H #7580-6 DUPLEX RECEPTACLES MOUNTED 48" ON CENTERS.
3. EXISTING OVERHEAD LIGHTS IN GALLERY 30 TO REMAIN.
4. ALL FUSES TO BE BUSSMANN LOW PEAK TYPE.
5. PROVIDE 3P 60A SWITCH IN EXISTING PANEL MDPI-FUSE @ 50A CONNECT AS REQUIRED-ALTERNATE NO. 1
6. PROVIDE 3P 30A SWITCH IN EXISTING PANEL MDPI-FUSE @ 20A CONNECT AS REQUIRED
7. ALL RACEWAY & WIRING SHALL BE RUN CONCEALED, UNLESS OTHERWISE NOTED.
8. DEVICE PLATES SHALL BE SATIN FINISHED STAINLESS STEEL.
9. ALL WIRE SHALL BE INSTALLED IN RIGID GALVANIZED STEEL CONDUIT.

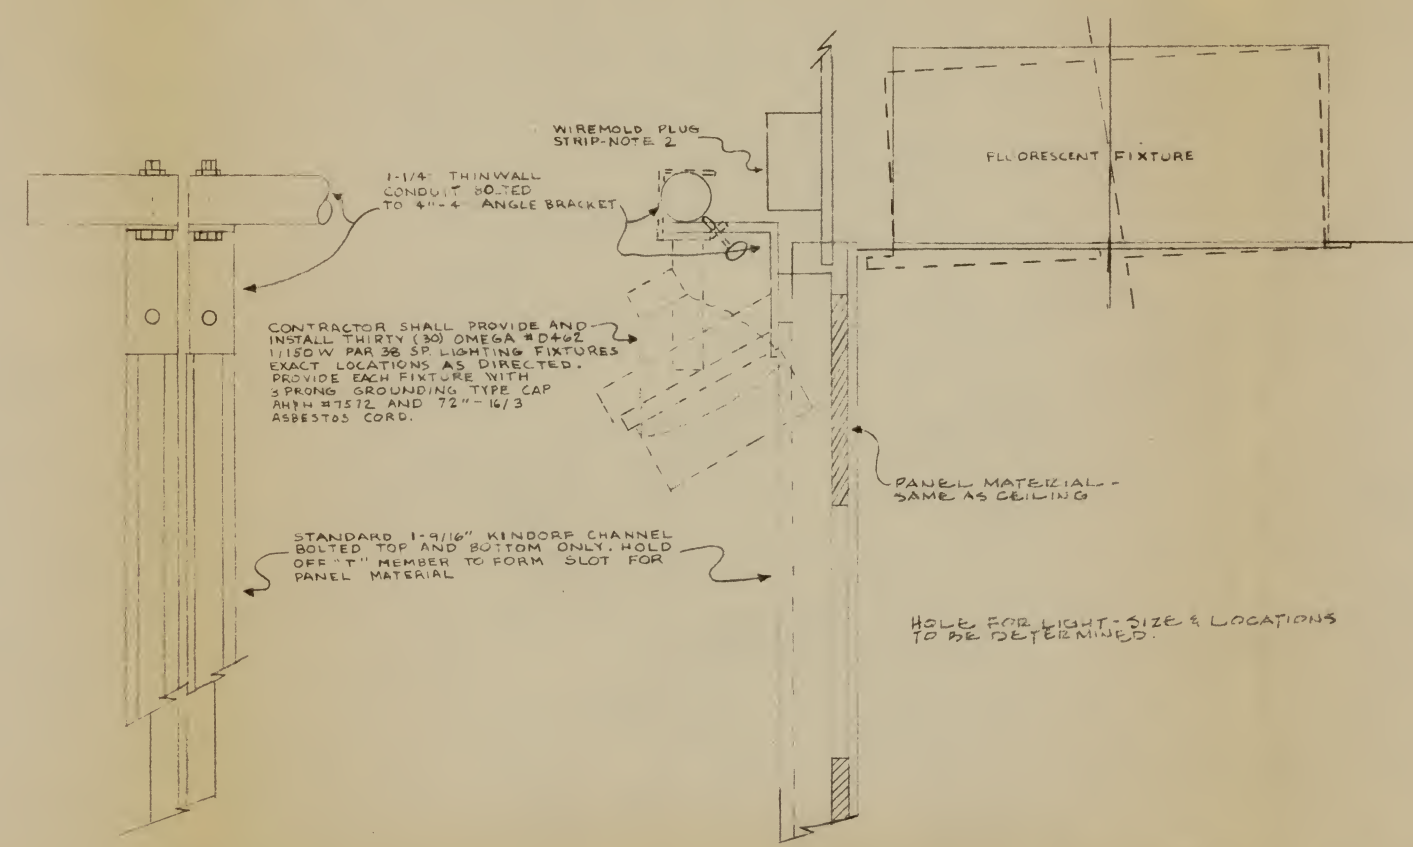

ELEVATION

SIDE

DETAIL "A" - SPOT LIGHTS MOUNTING DETAIL  
NO SCALE

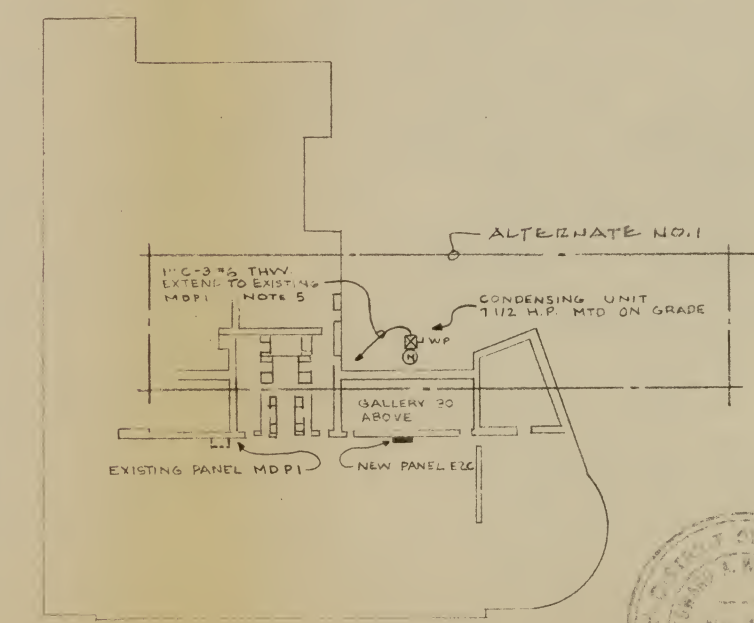

KEY PLAN  
NO SCALE




THE CORCORAN  
GALLERY OF ART  
WASHINGTON, D.C.  
PAUL M. KINGBURY & STEVENHOUSE ARCHITECTS  
1110 EIGHTH ST. N.W. WASHINGTON, D.C.

ALTERATIONS TO GALLERY 30

63-7  
DATE 7-1-64  
DRAWN BY F.W.D.  
CHECKED BY J.H.A.  
SCALE 1/4"=1'-0"  
E-1





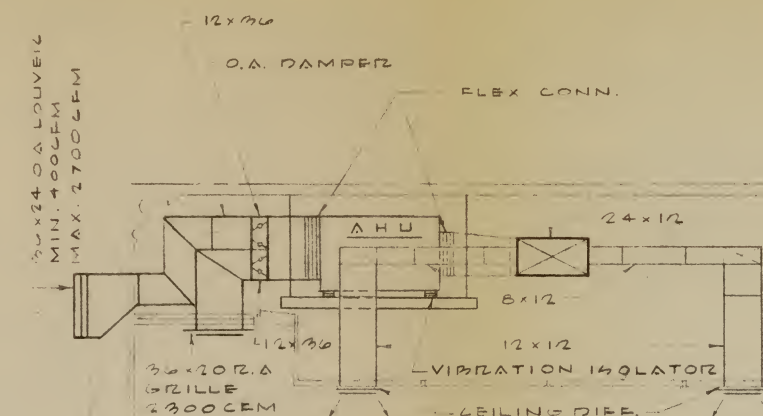


EQUIPMENT SCHEDULE

- BASE BID: PROVIDE ALL EQUIPMENT WITH EXCEPTION  
OF COOLING COIL, CONDENSING UNIT AND REFRIGERATION  
CONTROLS AND PIPING

ALTERNATE: ADDITIONAL AMOUNT FOR INSTALLING COOLING COIL, CONDENSING UNIT AND REFRIGERATION CONTROLS AND PIPING

SECTION - A - A

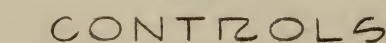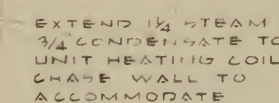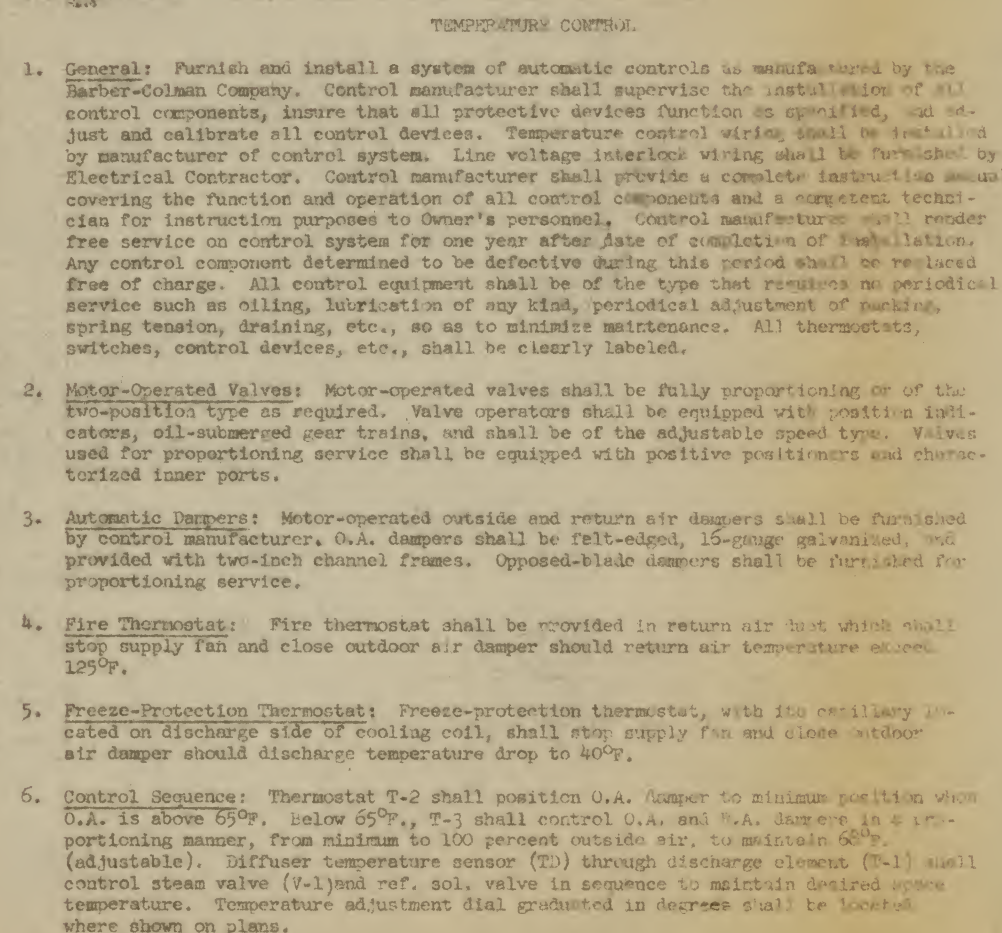SCALE:  $\frac{1}{4}'' = 1' - 0''$ 

CONTROL      LEGEND

C-10	CONTROL PANEL
M-1	DAMPFIB CONTROL MOTOR
R-2V	REF. SOL. VALVE
T-1	WALL MTD TEMP. ADJUSTOR
T-2	DISCHARGE TEMP SENSOR
T-1	DISCHARGE AIR ELEMENT
T-2	O.A. CHANGE-OVER STAT
T-3	MIXED AIR STAT
T-4	FIRE STAT
T-5	FREEZE STAT
V-1	STEAM VALVE

# PIPING CONNECTIONS

STEAM COIL



THE CORCORAN  
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PAULSEN, KINCHUR & STENHOUSE \* ARCHITECTS  
1110 N. 10TH ST. W. WASHINGTON, D. C.

# FLOOR PLAN SECTION & DETAILS

63-7

DATE  
7-1-64  
DRAWN BY  
M.R.M./J.H.  
CHECKED BY  
F.D.

EKS  
M-1

FRANK J. SULLIVAN ASSOCIATES  
Consulting Engineers  
2910 E. 27th, N.W. WASH., D. C.